


## FRAMING PLAN

SCALE: ¾6"= 1'-0"

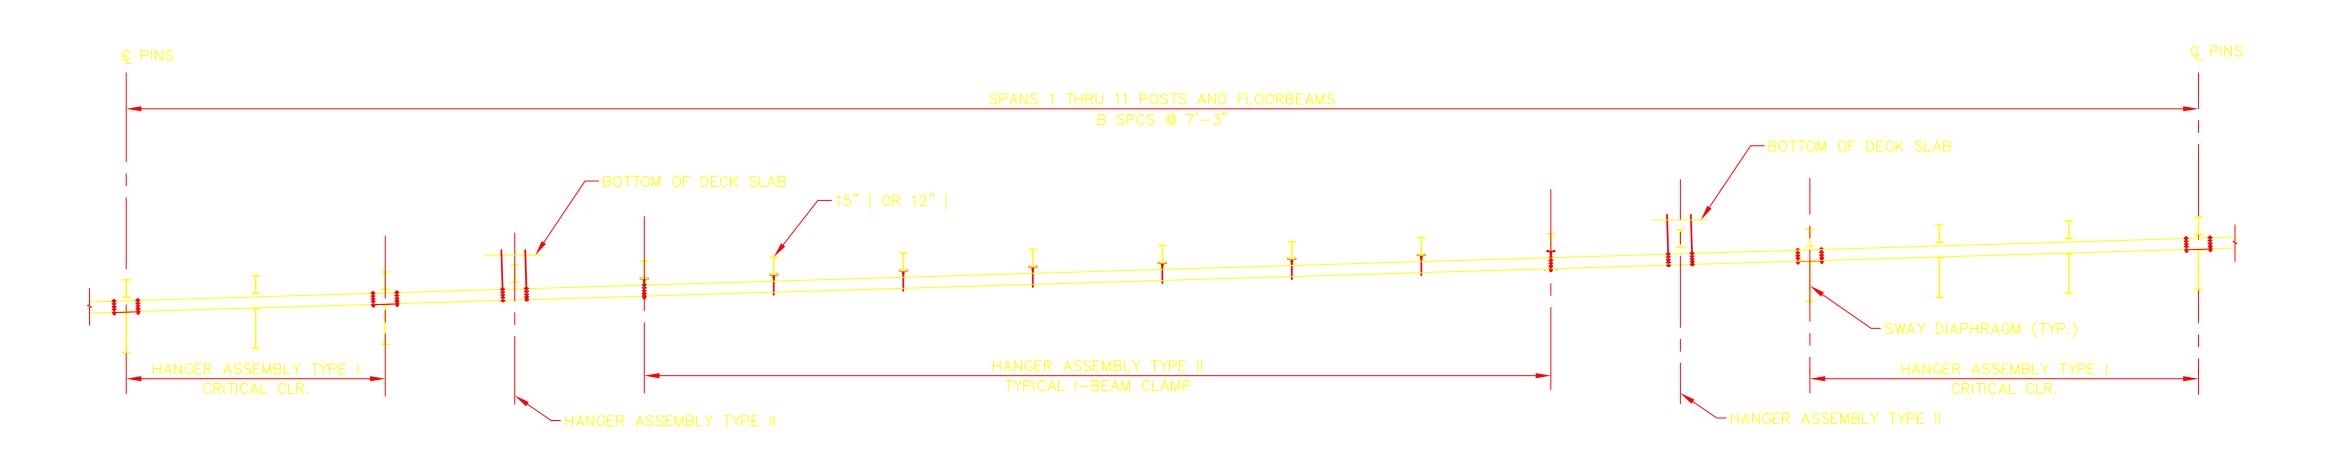


## FRAMING ELEVATION

SCALE: ¾6"= 1'-0"

FRAMING SCHEDULE				
SPAN	DIM A	B SPCS		
1, 11	101'-6"	14		
2, 10	116-0"	16		
3, 9	130'-6"	18		
4, 8	145'-0"	20		
5, 7	159'-6"	22		
	188'-6"	26		

CONDUIT HANGER ASSEMBLY SCHEDULE					
SPAN	BOSTON END - TYPE I	TYPE II	TYPE III	CAMBRIDGE END - TYPE I	
1	0	12	0	3	
2	3	10	0	4	
3	4	10	0	5	
4	5	10	0	6	
5	6	11	0	6	
6	7	8	0	5	
7	6	11	0	6	
8	6	10	0	5	
9	5	10	0	4	
10	4	10	0	3	
11	0	15	0	0	

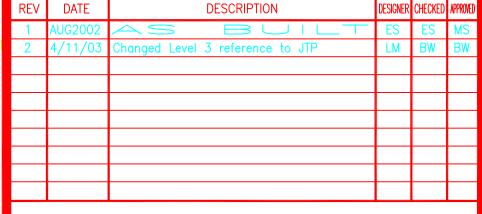



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APPROVED BY: MS





LOOP: BOSTON

SEGMENT: A-5

SITE ADDRESS:

BOSTON, MA

TITLE: FRAMING PLAN & CONDUIT HANGER ASSEMBLY SCHEDULE

SHEET:

CONTRACT NO: 5989

DRAWING NO: BOS5989P001R1

DATE DRAWN: AUG 2002

SCALE: N.T.S.

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